Date: Description: 06.11.25 DA ISSUE

Issue: Drawn:

# PROPOSED DUAL OCCUPANCY

**CLIENT:** O'BYRNE **STATUS:** DA ISSUE

**LOT No:** 32 **DP No:** 1272305

STREET: 179 MUDFORDS LANE, LANSDOWNE 2430

**CWC JOB #:** A6187

# **CONTENTS**


COI	NILIVIO	
SHEET#	SHEET NAME	REVISION
1	LEGENDS	F
2	OVERALL SITE PLAN	F
3	SITE PLAN	F
4	S68 PLAN	F
5	EXISTING FLOOR PLAN (UNIT 1)	F
6	PROPOSED FLOOR PLAN (UNIT 2)	F
7	ELEVATIONS	F
8	ELEVATIONS	F
9	SECTIONS	F
10	ROOF PLANS	F
11	GLAZING	F
12	PERSPECTIVE VIEW	F
17	BUILDING SPECIFICATIONS	F
18	WORK SAFETY NOTES	F



#### GENERIC | TYPICAL KEY, LEGEND AND ABBREVIATIONS FOR COLLINS W COLLINS ARCHITECTURAL PLANS

THESE NOTES MUST BE READ AND UNDERSTOOD BY ALL INVOLVED IN THE PROJECT. THIS INCLUDES (but is not limited to): OWNER, BUILDER, SUB-CONTRACTORS, CONSULTANTS, RENOVATORS, OPERATORS, MAINTAINERS, DEMOLISHERS. PLEASE USE THIS IN CONJUNCTION WITH ALL DRAWING SHEETS AND VIEWS CONTAINED FORTHWITH IN THIS PLAN SET. REVISED JANURARY 2021

#### SYMBOLS AND LINES

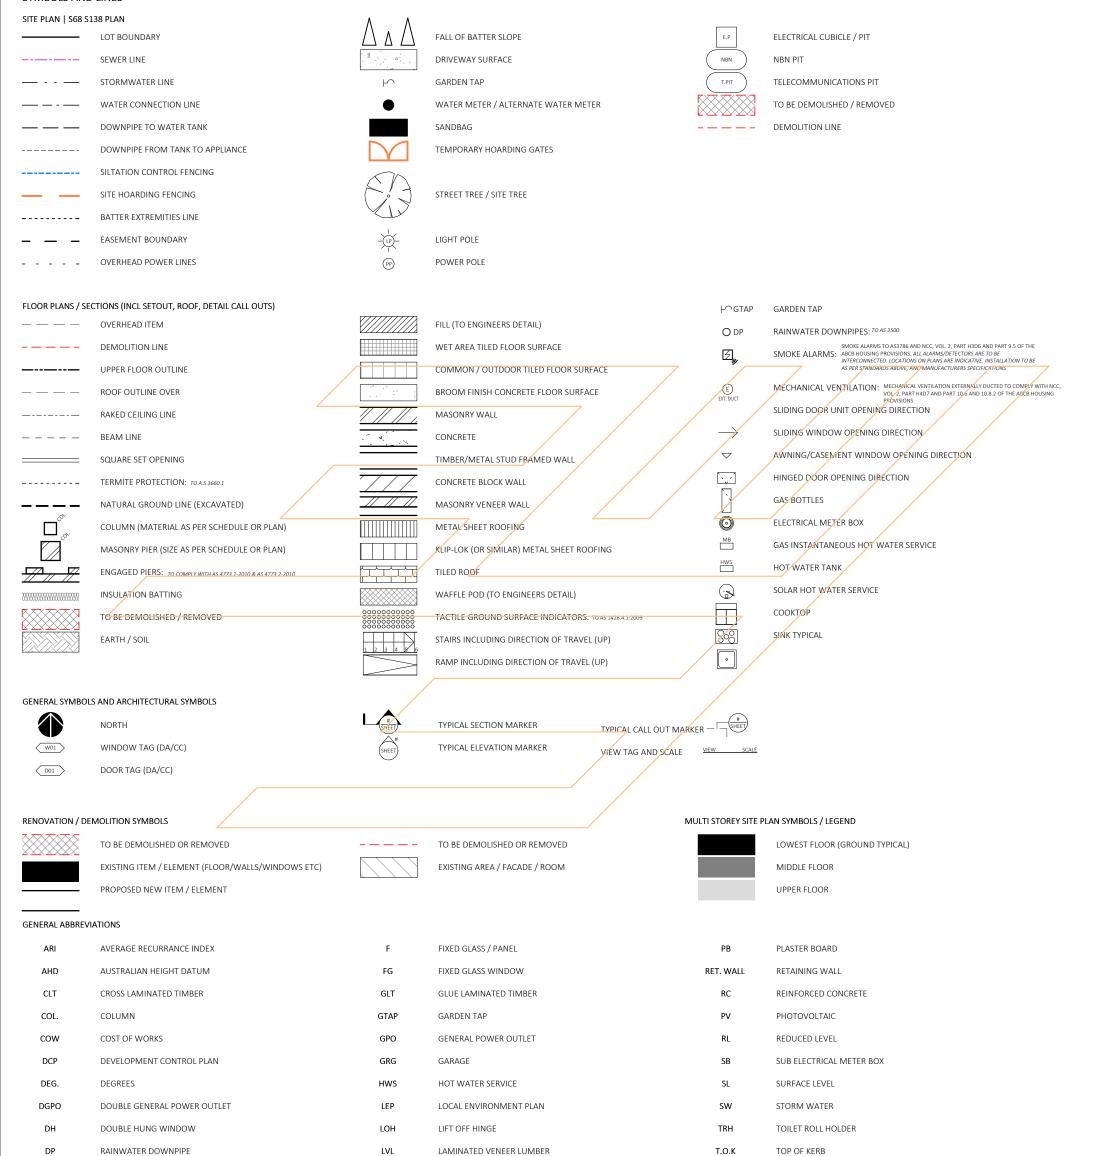

3//
Collins W Collins Building Designers

DOUBLE TOWEL RAIL

HOT WATER SERVICE

FINISHED SURFACE LEVEL

FIBRE CEMENT

DTR

**HWS** 

FC

F.S.L

Note: Copyright © Collins.w.Collins PTY LTD Ill rights reserved. No part of this drawing m produced or transmitted in any ctronic, mechanical, photocop wise, without the prior per O NOT SCALE from this drawing neck all the dimensions on the jo mmencement of shop drawings or fabrication crepancies to be referred to the consultant

esigner prior to commencement of work.

_	15 1 1 1 2 1 2
P	drawing may be
	form or by means,
_	ying, recording or
_ >	nission of the
1	
-	CONTRACTOR is to
S	ob prior to
	s or fabrication.

PROJECT: PROPOSED DUAL OCCUPA	NCY		
STATUS: DA ISSUE	SHEET: 1 OF 17		
LOT No: 32 DP No: 1272305	SHEET:	1 01 17	
STREET: 179 MUDFORDS LANE, LAN	SDOWNE	2430	

MECHANICAL

MAN HOLE

FLECTRICAL METER BOX

MOISTURE RESISTANT

NATURAL GROUND LINE

MECH.

MB

 $\mathsf{MR}$ 

МН

NGL

CLIENT: O'BYRNE

LEGENDS		
		Date:
SCALE:	1:100	15.07.25
	_	31.07.25
SHEET SIZE:	A3	08.08.25
START DATE:	06.06.2025	26.08.25
DWG No:	A6187	29.08.25
DVV G IVO.	I AUTO/	Inc 11 2E

T.O.W

WC

1650B

900V

820

DRAWING REVISION + NOTES Revision: Issue: Drawn: INITIAL ISSUE REVISION ΙAΕ REVISED ΑE CC PLANS MS REV DA PLANS ΑE

T: 02 6583 4411


TOP OF WALL

WATER CLOSET

BATH SIZING

VANITY SIZING

INTERIOR DOOR SIZING

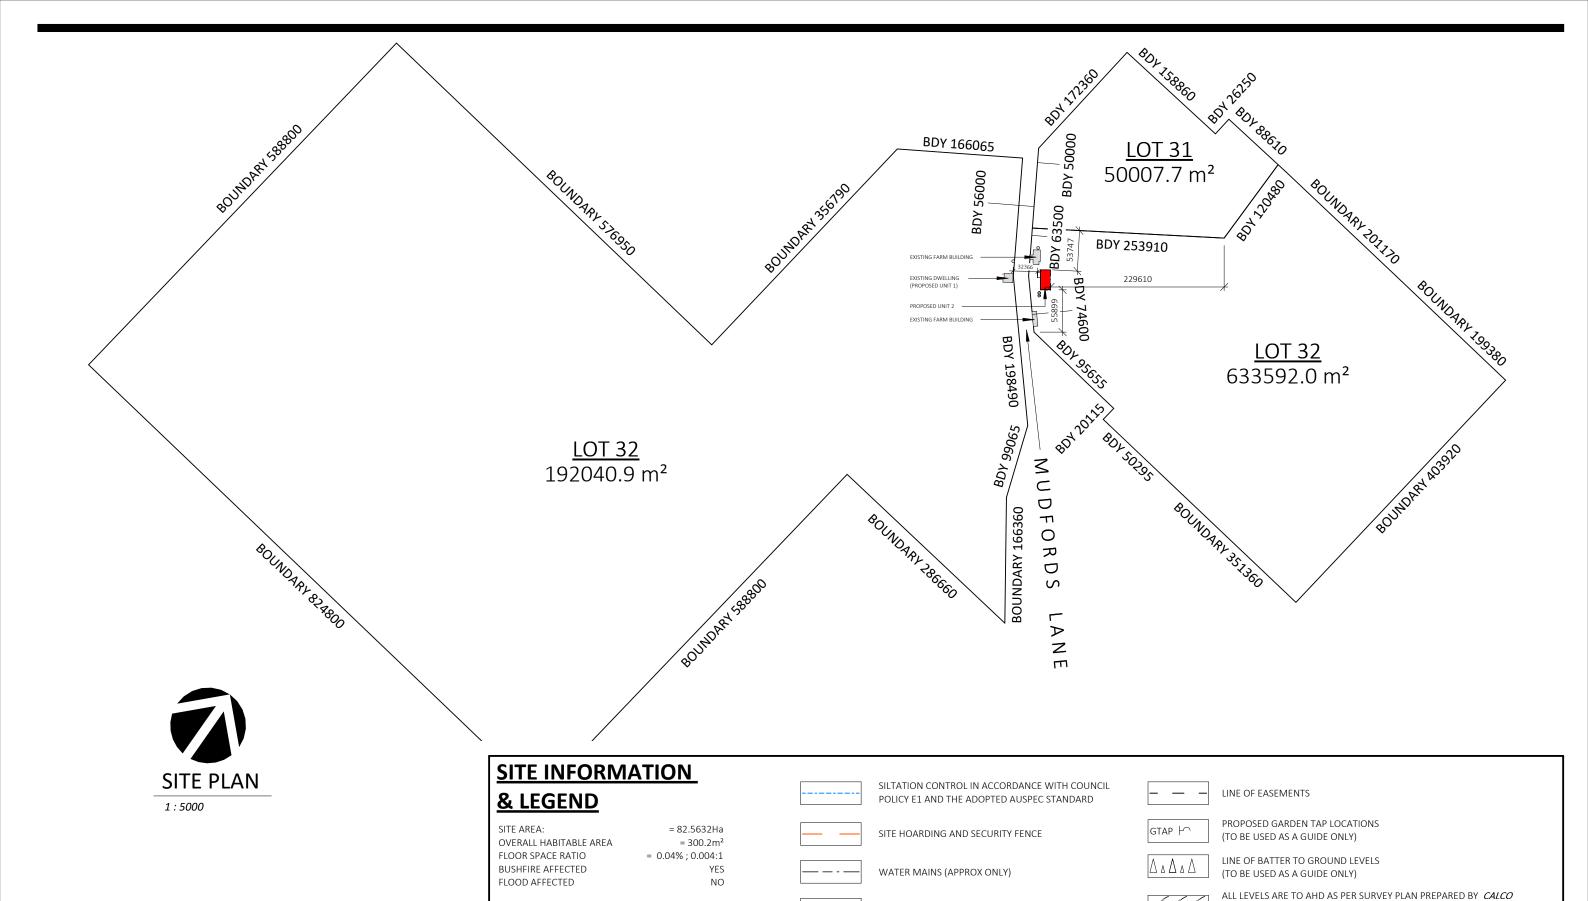



ROTE: Cop All rights reproduce means, ele recording permission DO NOT SC to check a commendation of the co

Note: Copyright © Collins.w.Collins PTY LTD
All rights reserved. No part of this drawing may be
reproduced or transmitted in any form or by
means, electronic, mechanical, photocopying,
recording or otherwise, without the prior
permission of the copyright holders.
DO NOT SCALE from this drawing. CONTRACTOR is
to check all the dimensions on the job prior to
commencement of shop drawings or fabrication.
Discrepancies to be referred to the consultant
Designer prior to commencement of work.

PROJECT: PROPOSED DUAL OCCUPANCY

STATUS: DA ISSUE

LOT No: 32 DP No: 1272305

STREET: 179 MUDFORDS LANE, LANSDOWNE 2430

**CLIENT:** O'BYRNE

STORMWATER LINES (APPROX ONLY)

SEWER LINES (APPROX ONLY)

SHEET: 2 OF 17 SCAI SHEET: 2430

OVERALL SITE PLAN

SCALE: As indicated

SHEET SIZE: A3

START DATE: 06.06.2025

DRAWING REVISION + NOTES

START OF CONSTRUCTION.

SURVEYORS PTY LTD (dd: 11.07.2025 Ref 4419) . ALL LEVELS AND CONTOURS ARE TO BE CONFIRMED BY BUILDER / SURVEYOR PRIOR TO


A Lord Street (PO Box 5667), Port Macquarie NSW 2444 | Shop 17 Centrepoint Arcade, Taree NSW 2430 | 77 Belgrave Street, Kempsey, NSW 2440

DWG No: T: 02 6583 441

WWW. COLLINSWCOLLINS.COM.AU

Issue: Drawn

MS AE

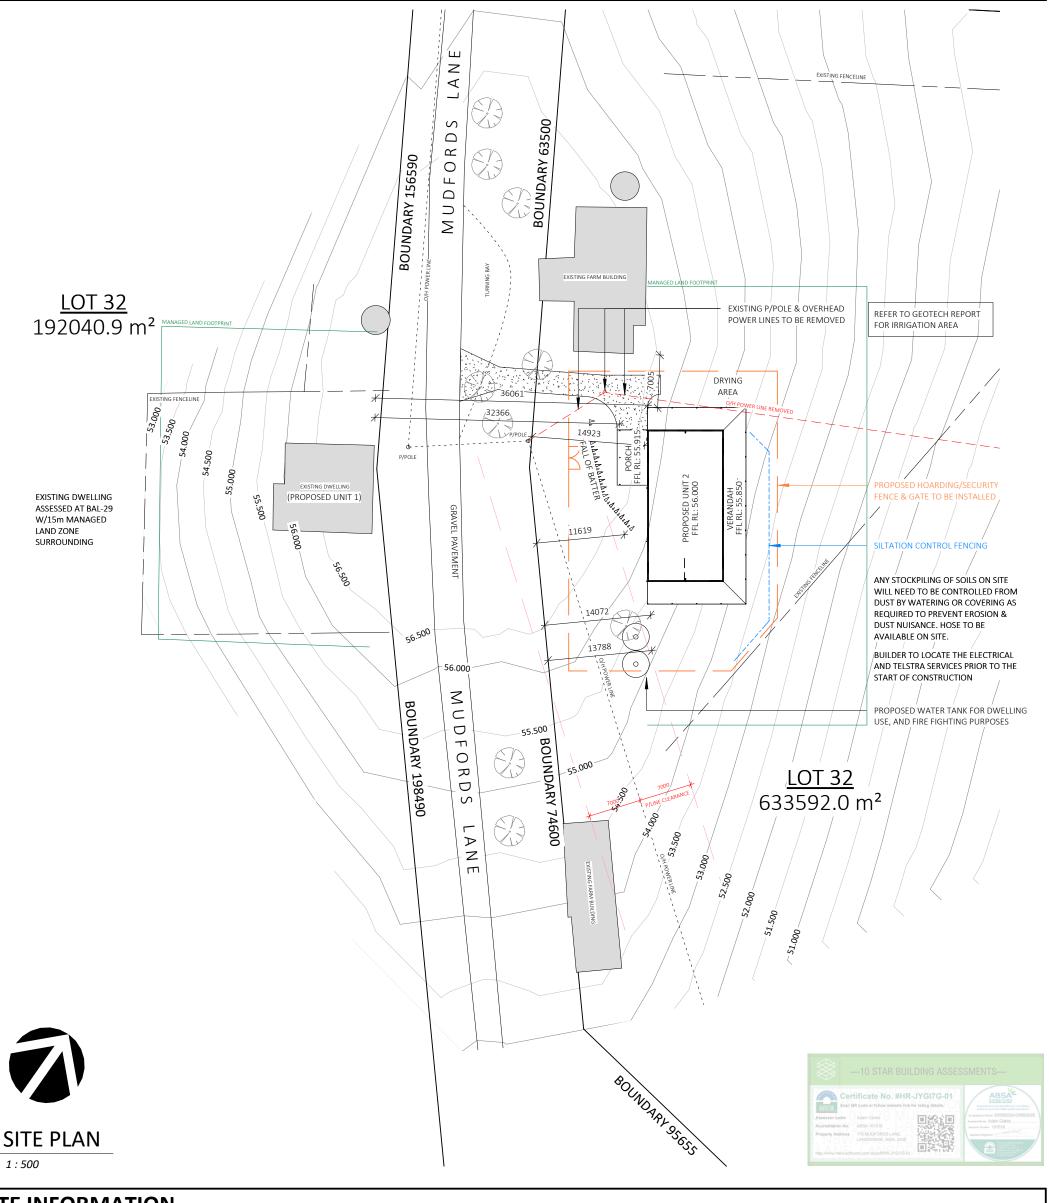

## **SITE INFORMATION & LEGEND**

SITE AREA: OVERALL HABITABLE AREA FLOOR SPACE RATIO BUSHFIRE AFFECTED FLOOD AFFECTED

= 82.5632Ha  $= 300.2 m^2$ = 0.04%; 0.004:1 YES

NO

SILTATION CONTROL IN ACCORDANCE WITH COUNCIL POLICY E1 AND THE ADOPTED AUSPEC STANDARD





SITE HOARDING AND SECURITY FENCE



WATER MAINS (APPROX ONLY)



STORMWATER LINES (APPROX ONLY)



SEWER LINES (APPROX ONLY)



LINE OF EASEMENTS



PROPOSED GARDEN TAP LOCATIONS (TO BE USED AS A GUIDE ONLY)



LINE OF BATTER TO GROUND LEVELS (TO BE USED AS A GUIDE ONLY)



ALL LEVELS ARE TO AHD AS PER SURVEY PLAN PREPARED BY *CALCO* SURVEYORS PTY LTD (dd: 11.07.2025 Ref 4419) . ALL LEVELS AND CONTOURS ARE TO BE CONFIRMED BY BUILDER / SURVEYOR PRIOR TO START OF CONSTRUCTION.

DRAWING REVISION + NOTES



Note: Copyright © Collins.w.Collins PTY LTD
All rights reserved. No part of this drawing may be reproduced or transmitted in any form or by means electronic, mechanical, photocopying, recording or electronic, ineclianical, priococopying, recording or otherwise, without the prior permission of the copyright holders.

DO NOT SCALE from this drawing. CONTRACTOR is t check all the dimensions on the job prior to commencement of shop drawings or fabrication. Discrepancies to be referred to the consultant Designer prior to commencement of work.

PROPOSED DUAL OCCUPANCY STATUS: DA ISSUE SHEET: 3 OF 17 LOT No: 32 DP No: 1272305 STREET: 179 MUDFORDS LANE, LANSDOWNE 2430

SITE PLAN Date: SCALE: 15.07.25 As indicated 31.07.25 SHEET SIZE: А3 08.08.25 26.08.25 START DATE: 06.06.2025 29.08.25 DWG No:

Revision: INITIAL ISSUE REVISION REVISED CC PLANS REV DA PLANS

ΑE

Issue: Drawn:

AE


ΑE

MS

89A Lord Street (PO Box 5667), Port Macquarie nsw 2444 | Shop 17 Centrepoint Arcade, Taree NSW 2430 | 77 Belgrave Street, Kempsey, NSW

CLIENT: O'BYRNE


A6187 T: 02 6583 4411

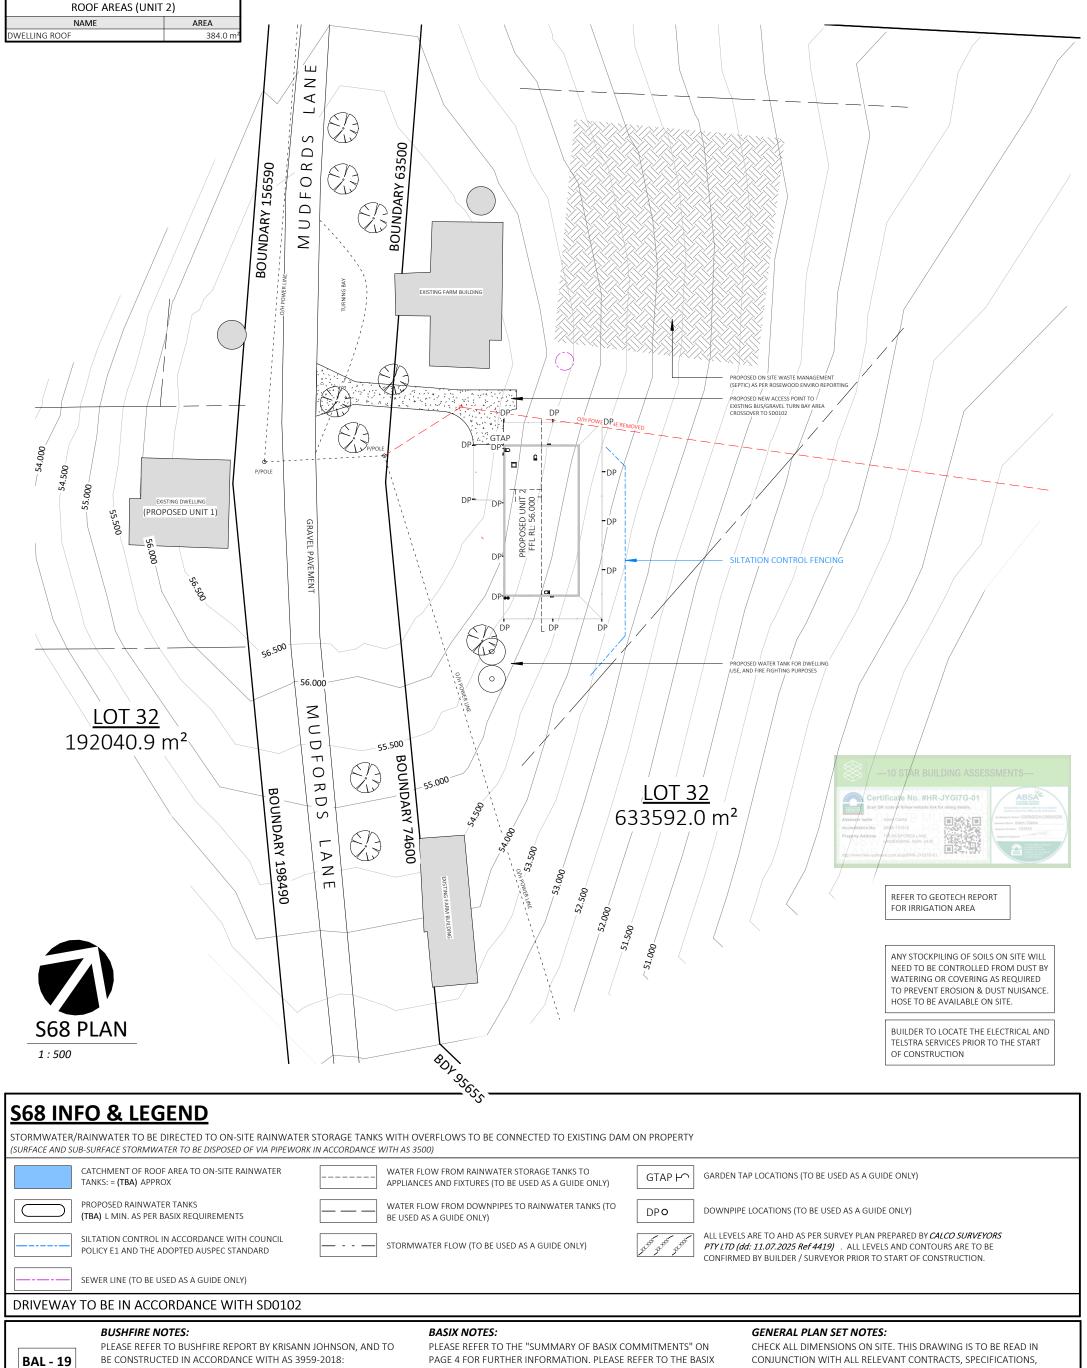


CONSTRUCTION OF BUILDINGS IN BUSHFIRE PRONE AREAS

CERTIFICATE FOR EXACT DETAILS

REPORTS, DRAWINGS, LEGENDS, NATIONAL CONSTRUCTION CODE, AUS & NZ STANDARDS, ENGINEERING & COUNCIL APPROVALS

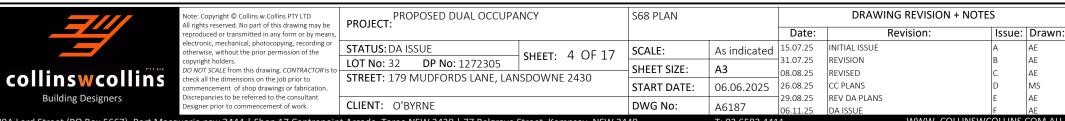


	EXTERNAL FINISHES
LABEL	MATERIAL DESCRIPTION
CORR(L)	CORRUGATED METAL SHEET ROOFING (LIGHT)
GUT(A)	CLIP-SNAP CONTINUOUS OVERFLOW EAVES
	GUTTER SYSTEM TO COMPLY WITH AS 3500.3
SC(V)	SELECT VERTICAL PROFILE CLADDING
VSM	VERSICLAD SPACEMAKER (50mm)

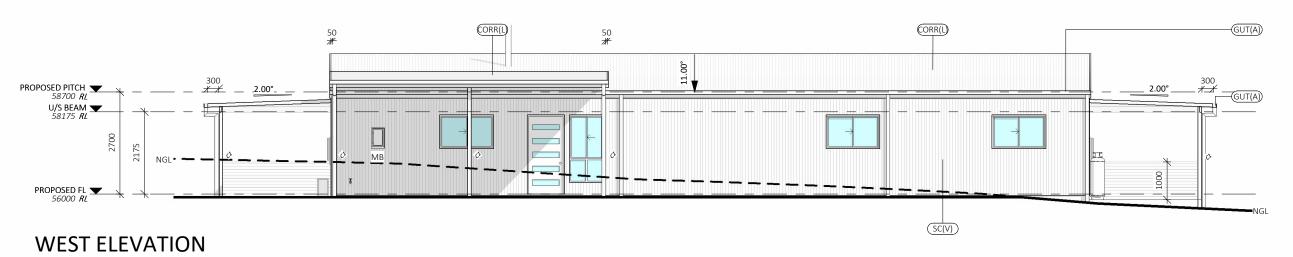

1:100

HANDRAIL HEIGHT TO BE NO LESS THAN 1000mm FROM PROPOSED FINISHED FL. BALUSTRADE & HANDRAIL TO BE IN ACCORDANCE WITH NCC, VOL. 2, PART 11.3.3, 11.3.4 AND 11.3.5 OF THE ABCB HOUSING PROVISIONS

ALL TIMBER DECKS, STAIRS AND EXTERNAL TIMBER COLUMNS ARE TO BE CONSTRUCTED FROM BUSHFIRE RESISTING TIMBER SPECIES AS PER AS3959, APPENDIX F

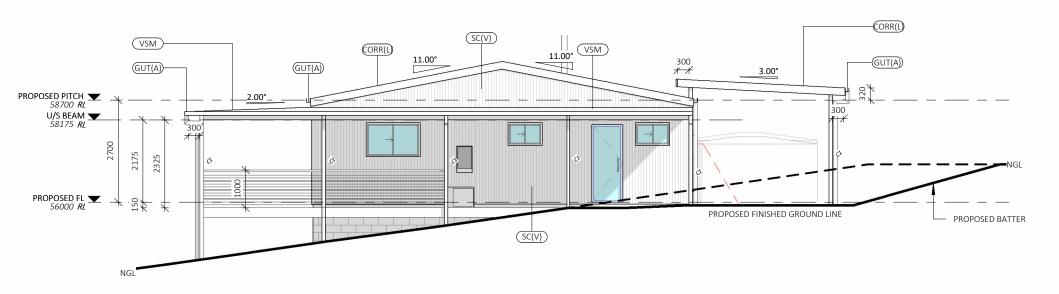

### **NORTH ELEVATION**

1:100

#### **BUSHFIRE NOTES:**

PLEASE REFER TO BUSHFIRE REPORT BY KRISANN JOHNSON, AND TO BE CONSTRUCTED IN ACCORDANCE WITH AS 3959-2018: CONSTRUCTION OF BUILDINGS IN BUSHFIRE PRONE AREAS

#### **BASIX NOTES:**

PLEASE REFER TO THE "SUMMARY OF BASIX COMMITMENTS" ON PAGE 4 FOR FURTHER INFORMATION. PLEASE REFER TO THE BASIX CERTIFICATE FOR EXACT DETAILS

#### **GENERAL PLAN SET NOTES:**

CHECK ALL DIMENSIONS ON SITE. THIS DRAWING IS TO BE READ IN CONJUNCTION WITH ALL RELEVANT CONTRACTS, SPECIFICATIONS, REPORTS, DRAWINGS, LEGENDS, NATIONAL CONSTRUCTION CODE, AUS & NZ STANDARDS, ENGINEERING & COUNCIL APPROVALS



BAL - 19


Note: Copyright © Collins.w.Collins PTY LTD All rights reserved. No part of this drawing may be reproduced or transmitted in any form or by means, electronic, mechanical, photocopying, recording or otherwise, without the prior permission of the copyright holders. DO NOT SCALE from this drawing. CONTRACTOR is to check all the dimensions on the job prior to commencement of shop drawings or fabrication Discrepancies to be referred to the consultant Designer prior to commencement of work.

PROJECT: PROPOSED DUAL OCCUPANCY			ELEVATIONS
STATUS: DA ISSUE	SHEET: 7 OF 17		SCALE:
LOT No: 32 DP No: 1272305	JIILLI.	7 01 17	SHEET SIZE:
STREET: 179 MUDFORDS LANE, LANSDOWN	SHEET SIZE.		
			START DATE
CLIENT: O'BYRNE	DWG No:		

		Date:	Revision:	Issue:	Drawn:
SCALE:	1:100	15.07.25	INITIAL ISSUE	А	AE
		31.07.25	REVISION	В	AE
SHEET SIZE:	A3	08.08.25	REVISED	С	AE
START DATE:	06.06.2025	26.08.25	CC PLANS	D	MS
		29.08.25	REV DA PLANS	E	AE
DWG No:	A6187	06.11.25	DA ISSUE	F	AE

DRAWING REVISION + NOTES

	EXTERNAL FINISHES
LABEL	MATERIAL DESCRIPTION
CORR(L)	CORRUGATED METAL SHEET ROOFING (LIGHT)
GUT(A)	CLIP-SNAP CONTINUOUS OVERFLOW EAVES
	GUTTER SYSTEM TO COMPLY WITH AS 3500.3
SC(V)	SELECT VERTICAL PROFILE CLADDING
VSM	VERSICLAD SPACEMAKER (50mm)

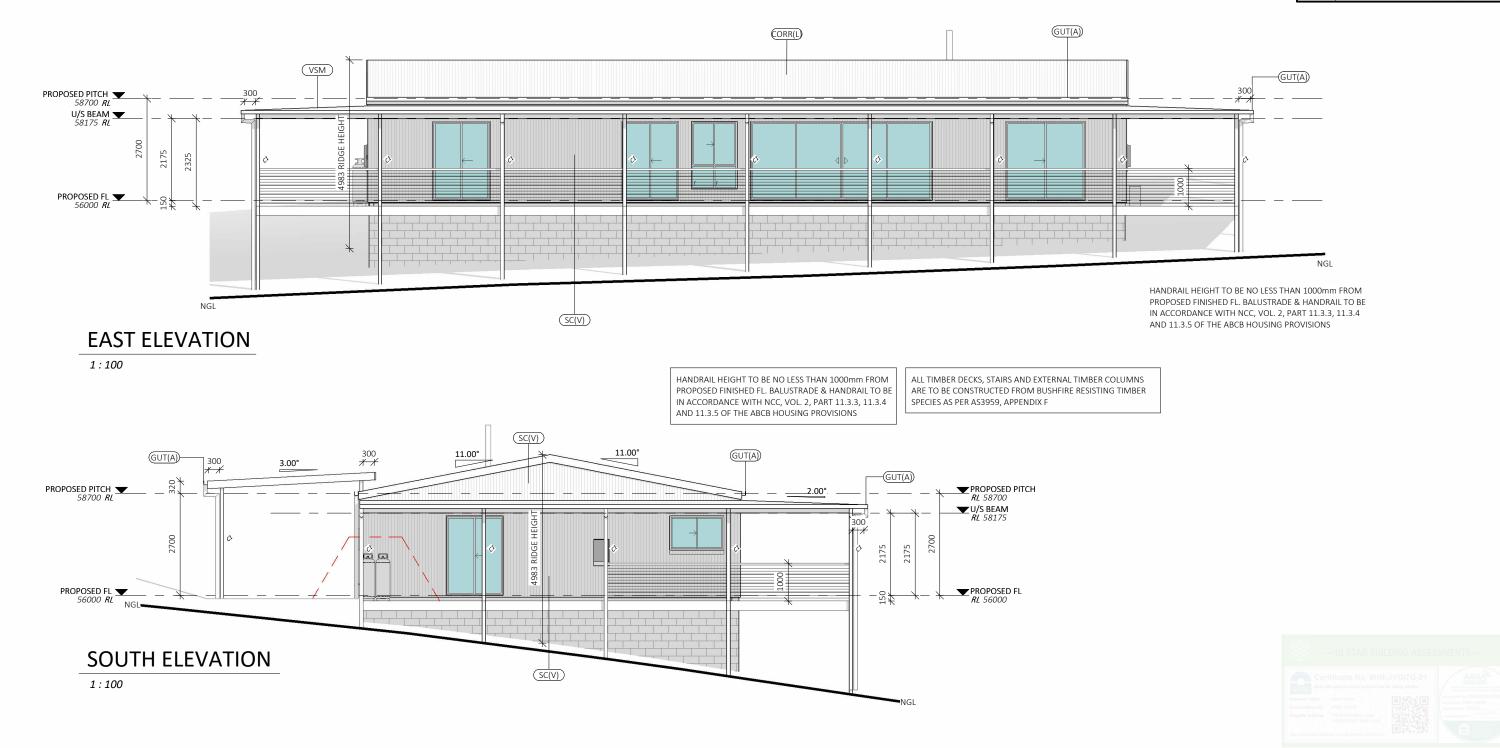

#### **BUSHFIRE NOTES:**

PLEASE REFER TO BUSHFIRE REPORT BY KRISANN JOHNSON, AND TO BE CONSTRUCTED IN ACCORDANCE WITH AS 3959-2018: CONSTRUCTION OF BUILDINGS IN BUSHFIRE PRONE AREAS

#### **BASIX NOTES:**

PLEASE REFER TO THE "SUMMARY OF BASIX COMMITMENTS" ON PAGE 4 FOR FURTHER INFORMATION. PLEASE REFER TO THE BASIX CERTIFICATE FOR EXACT DETAILS

#### **GENERAL PLAN SET NOTES:**

CHECK ALL DIMENSIONS ON SITE. THIS DRAWING IS TO BE READ IN CONJUNCTION WITH ALL RELEVANT CONTRACTS, SPECIFICATIONS, REPORTS, DRAWINGS, LEGENDS, NATIONAL CONSTRUCTION CODE, AUS & NZ STANDARDS, ENGINEERING & COUNCIL APPROVALS

WWW. COLLINSWCOLLINS.COM.AU



BAL - 19

Note: Copyright © Collins.w.Collins PTY LTD All rights reserved. No part of this drawing may be reproduced or transmitted in any form or by means, electronic, mechanical, photocopying, recording or otherwise, without the prior permission of the copyright holders. permission of the copyright notices.


DO NOT SCALE from this drawing. CONTRACTOR is to check all the dimensions on the job prior to commencement of shop drawings or fabrication. Discrepancies to be referred to the consultant Designer prior to commencement of work.

PROJECT: PROPOSED DUAL OCCUPANCY			ELEVATIONS		DRAWING REVISION + NOTES			
					Date:	Revision:	Issue:	Drawn:
STATUS: DA ISSUE	CHEET.	8 OF 17	SCALE:	1:100	15.07.25	INITIAL ISSUE	А	AE
LOT No: 32 DP No: 1272305	SHEET: 8 OF 17		CLIEFT CITE		31.07.25	REVISION	В	AE
STREET: 179 MUDFORDS LANE, LANSDOWNI	2430		SHEET SIZE:	A3	08.08.25	REVISED	С	AE
•			START DATE:	06.06.2025		CC PLANS		MS
0.1515					29.08.25	REV DA PLANS	E	AE
CLIENT: O'BYRNE		DWG No:	A6187	06.11.25	DA ISSUE	F	AE	

ROOF AREAS (UNIT 2) NAME AREA DWELLING ROOF 384.0 m

	EXTERNAL FINISHES
LABEL	MATERIAL DESCRIPTION
CORR(L)	CORRUGATED METAL SHEET ROOFING (LIGHT)
GUT(A)	CLIP-SNAP CONTINUOUS OVERFLOW EAVES
	GUTTER SYSTEM TO COMPLY WITH AS 3500.3
SC(V)	SELECT VERTICAL PROFILE CLADDING
VSM	VERSICLAD SPACEMAKER (50mm)

	COLUMN SCHEDULE
LABEL	COLUMN TYPE
C1	90 x 90mm HARDWOOD POST ON STIRRUP
C2	EXTENDA BRACKET
C3	C25019

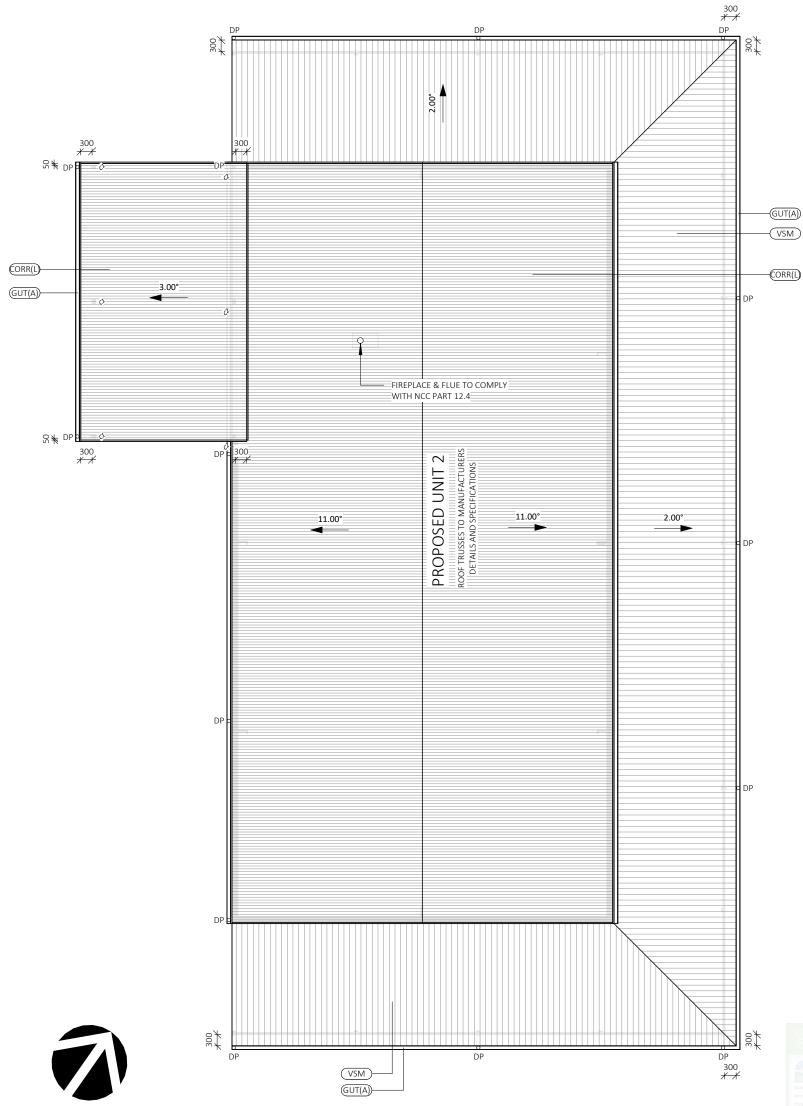



#### **BUSHFIRE NOTES:**

**ROOF PLAN** 

PLEASE REFER TO BUSHFIRE REPORT BY KRISANN JOHNSON, AND TO BE CONSTRUCTED IN ACCORDANCE WITH AS 3959-2018: CONSTRUCTION OF BUILDINGS IN BUSHFIRE PRONE AREAS

#### **BASIX NOTES:**

PLEASE REFER TO THE "SUMMARY OF BASIX COMMITMENTS" ON PAGE 4 FOR FURTHER INFORMATION. PLEASE REFER TO THE BASIX CERTIFICATE FOR EXACT DETAILS

#### **GENERAL PLAN SET NOTES:**

CHECK ALL DIMENSIONS ON SITE. THIS DRAWING IS TO BE READ IN CONJUNCTION WITH ALL RELEVANT CONTRACTS, SPECIFICATIONS, REPORTS, DRAWINGS, LEGENDS, NATIONAL CONSTRUCTION CODE, AUS & NZ STANDARDS, ENGINEERING & COUNCIL APPROVALS



1:100

**BAL - 19** 

Note: Copyright © Collins, w.Collins PTY LTD All rights reserved. No part of this drawing ma reproduced or transmitted in any form or by reproduced or transmitted in any form or by melectronic, mechanical, photocopying, recording otherwise, without the prior permission of the copyright holders.

DO NOT SCALE from this drawing. CONTRACTOR check all the dimensions on the job prior to commencement of shop drawings or fabrication Discrepancies to be referred to the consultant Designer prior to commencement of work.

wing may be	PR
m or by means,	
, recording or on of the	STA
NTRACTOR is to	LO
rior to	STF
fabrication	

PROPOSED DUAL OCCUPANCY			
TATUS: DA ISSUE	SHEET: 10 OF 17		
OT No: 32 DP No: 1272305	SHEET: 10 OF 17		
TREET: 179 MUDFORDS LANE, LAN	SDOWNE 2430		


		Date:
SCALE:	1:100	15.07.25
		31.07.25
SHEET SIZE:	A3	08.08.25
START DATE:	06.06.2025	26.08.25
DIA/C NI-		29.08.25
DWG No:	A6187	06.11.25


ROOF PLANS

ite:	Revision:	Issue:	Drawn:	
.25	INITIAL ISSUE	А	AE	
.25	REVISION	В	AE	
.25	REVISED	С	AE	
.25	CC PLANS	D	MS	
.25	REV DA PLANS	E	AE	
25	DA ISSUE	F	AF	

DRAWING REVISION + NOTES

**CLIENT**: O'BYRNE

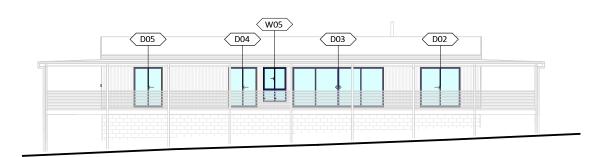

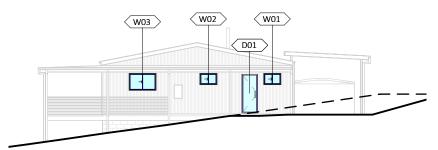


#### **EAST GLAZING**

1:200

#### **NORTH GLAZING**

1:200

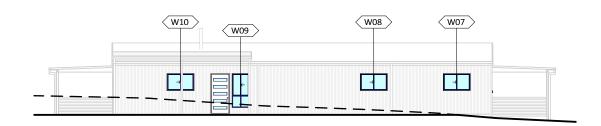

# SOUTH GLAZING

#### **WEST GLAZING**

1:200

1:200

WINDOW GLAZING SCHEDULE								
NUMBER	ROOM	HEIGHT	WIDTH	HEAD HEIGHT	TYPE	CONSTRUCTION	GLAZING	AREA
W01	PWDR	600	910	2100	SLIDING	ALUMINIUM	STANDARD	0.55 m <sup>2</sup>
W02	ENS	600	910	2100	SLIDING	ALUMINIUM	STANDARD	0.55 m <sup>2</sup>
W03	MASTER (1)	900	1430	2100	SLIDING	ALUMINIUM	STANDARD	1.29 m²
W05	LIVING/DINING	1800	1210	2100	SLIDING 2T	ALUMINIUM	STANDARD	2.18 m <sup>2</sup>
W06	BED 3	900	1430	2100	SLIDING	ALUMINIUM	STANDARD	1.29 m²
W07	BED 4	900	1430	2100	SLIDING	ALUMINIUM	STANDARD	1.29 m²
W08	MPR	900	1430	2100	SLIDING	ALUMINIUM	STANDARD	1.29 m²
W09	ENTRY	1800	910	2100	SLIDING	ALUMINIUM	STANDARD	1.64 m²
W10	MUD/UTILITY	900	1430	2100	SLIDING	ALUMINIUM	STANDARD	1.29 m²
$11.34~\mathrm{m}^2$								

DOOR GLAZING SCHEDULE								
NUMBER	ROOM	HEIGHT	WIDTH	HEAD HEIGHT	TYPE	CONSTRUCTION	GLAZING	AREA
D02	MASTER (1)	2100	2110	2100	SLIDING DOOR	ALUMINIUM	STANDARD	4.43 m²
D03	LIVING/DINING	2100	4810	2100	SLIDING DOOR 4P	ALUMINIUM	STANDARD	10.10 m <sup>2</sup>
D04	BED 2	2100	1510	2100	SLIDING DOOR	ALUMINIUM	STANDARD	3.17 m²
D05	BED 3	2100	1510	2100	SLIDING DOOR	ALUMINIUM	STANDARD	3.17 m²
D06	BED 4	2100	1510	2100	SLIDING DOOR	ALUMINIUM	STANDARD	3.17 m <sup>2</sup>
								24.05 m <sup>2</sup>

**CLIENT**: O'BYRNE



#### **GLAZING SPECIFICATIONS:**

WINDOWS AND DOORS SPECIFIED USE NFRC UW & SHGCW VALUES. WINDOWS AND DOORS AS SPECIFIED OR EQUIVALENT MUST BE INSTALLED ON SITE

STANDARD GLAZING: SINGLE CLEAR GLAZING WITH STANDARD ALUMINIUM FRAMES THROUGHOUT

WEATHER STRIPPING TO BE INSTALLED THROUGHOUT.

PLEASE NOTE: ALL GLAZING IN BATHROOMS, ENSUITES, SPA ROOMS OR THE LIKE TO COMPLY WITH THE NCC, VOL. 2, H1D8 AND PART 8.4.6 OF ABCB HOUSING PROVISIONS

#### WINDOWS AND GLAZING TO COMPLY WITH:

AS 4055: WIND LOADS FOR HOUSING AS 1288: GLASS IN BUILDINGS - SELECTION & INSTALLATION

AS 2047: WINDOWS & EXTERNAL DOORS IN BUILDING

AS 1170-Part 2 : WIND ACTIONS

REV DA PLANS

AS 3959: CONSTRUCTION OF BUILDINGS IN BUSHFIRE PRONE AREAS

\*THE STANDARDS REFERRED ABOVE ARE THE VERSION ADOPTED BY THE NCC AT THE TIME THE RELEVANT CONSTRUCTION CERTIFICATE OR COMPLYING DEVELOPMENT CERTIFICATE APPLICATION IS MADE.



Note: Copyright © Collins.w.Collins PTY LTD
All rights reserved. No part of this drawing may be
reproduced or transmitted in any form or by means,
electronic, mechanical, photocopying, recording or
otherwise, without the prior permission of the
copyright holders.
DO NOT SCALE from this drawing. CONTRACTOR is to
check all the dimensions on the job prior to
commencement of shop drawings or fabrication.
Discrepancies to be referred to the consultant
Designer prior to commencement of work.

PROJECT: PROF	POSED DUAL OCCUPA	.NCY
STATUS: DA ISS	SUE	SHEET: 11 (
L <b>OT No</b> : 32	DP No: 1272305	SHEEL: II C
STREET: 179 M	IUDFORDS LANE, LAN	ISDOWNE 243

	GLAZING		
			Date:
OF 17	SCALE:	As indicated	15.07.25
	SHEET SIZE:	A3	31.07.25 08.08.25
30	START DATE:	06.06.2025	26.08.25
	DWG No:	A6187	29.08.25

 DRAWING REVISION + NOTES

 ate:
 Revision:
 Issue:
 Drawn:

 2.25
 INITIAL ISSUE
 A
 AE

 2.25
 REVISION
 B
 AE

 3.25
 REVISED
 C
 AE


 3.25
 CC PLANS
 D
 MS


89A Lord Street (PO Box 5667), Port Macquarie nsw 2444 | Shop 17 Centrepoint Arcade, Taree NSW 2430 | 77 Belgrave Street, Kempsey, NSW 2440


T: 02 6583 4

WWW. COLLINSWCOLLINS.COM.AL

AE

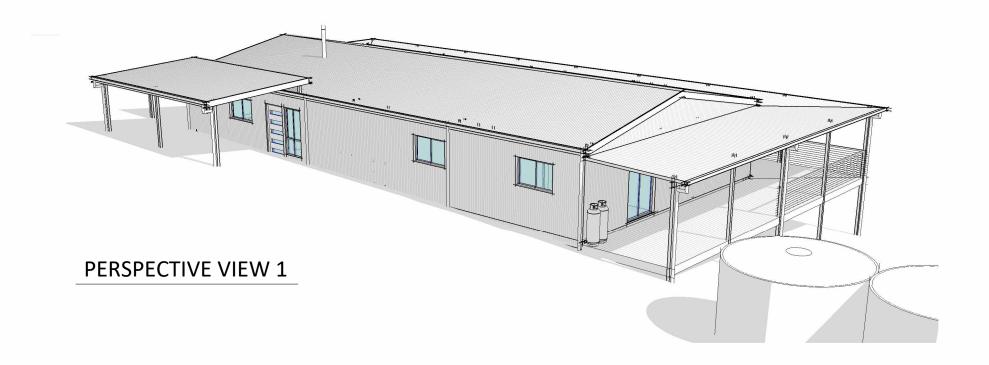

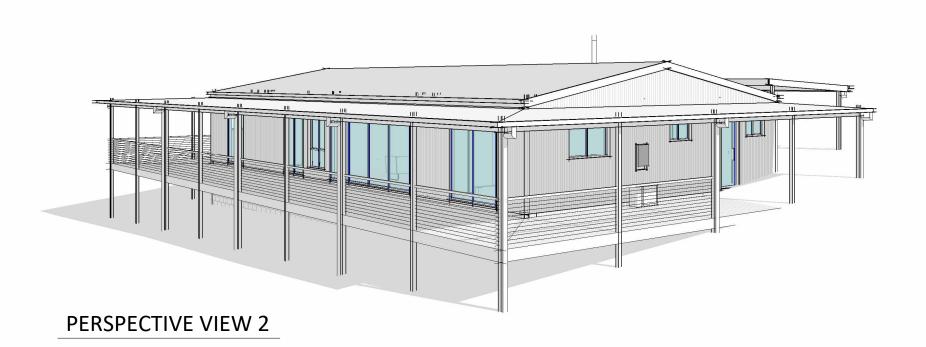

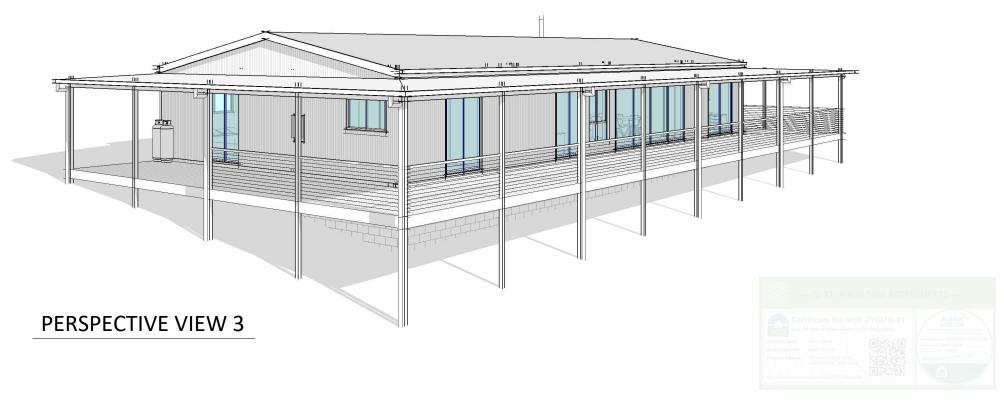

# DA ISSUE ONLY

Issue: Drawn:

AE

AE

MS

AE



#### **BUSHFIRE NOTES:**

PLEASE REFER TO BUSHFIRE REPORT BY KRISANN JOHNSON, AND TO BE CONSTRUCTED IN ACCORDANCE WITH AS 3959-2018: CONSTRUCTION OF BUILDINGS IN BUSHFIRE PRONE AREAS

#### **BASIX NOTES:**

PLEASE REFER TO THE "SUMMARY OF BASIX COMMITMENTS" ON PAGE 4 FOR FURTHER INFORMATION. PLEASE REFER TO THE BASIX CERTIFICATE FOR EXACT DETAILS

#### **GENERAL PLAN SET NOTES:**

Date:

15.07.25 31.07.25

08.08.25

26.08.25

29.08.25

INITIAL ISSUE

REVISION

REVISED

CC PLANS

REV DA PLANS

CHECK ALL DIMENSIONS ON SITE. THIS DRAWING IS TO BE READ IN CONJUNCTION WITH ALL RELEVANT CONTRACTS, SPECIFICATIONS, REPORTS, DRAWINGS, LEGENDS, NATIONAL CONSTRUCTION CODE, AUS &NZ STANDARDS, ENGINEERING & COUNCIL APPROVALS

DRAWING REVISION + NOTES

Revision:



Note: Copyright © Collins.w.Collins PTY LTD All rights reserved. No part of this drawing may be reproduced or transmitted in any form or by means, electronic, mechanical, photocopying, recording or otherwise, without the prior permission of the copyright holders.

DO NOT SCALE from this drawing. CONTRACTOR is to

check all the dimensions on the job prior to commencement of shop drawings or fabrication. Discrepancies to be referred to the consultant Designer prior to commencement of work.

PROJECT: PROPOSED DUAL OCCUPANCY		PERSPECTIVE VIEW	
STATUS: DA ISSUE	SHEET: 12 OF 17	SCALE:	
LOT No: 32 DP No: 1272305		SHEET SIZE:	A3
STREET: 179 MUDFORDS LANE, LAN	START DATE:	06.06.2025	
CLIENT: O'BYRNE		DWG No:	A6187

89A Lord Street (PO Box 5667), Port Macquarie nsw 2444 | Shop 17 Centrepoint Arcade, Taree NSW 2430 | 77 Belgrave Street, Kempsey